Building address <u>327 Broadway Bethlehem, PA 18015</u> Owner of building <u>Sycamore Hill Farm Development</u> Phone <u>Phone</u> Phone	Applicant Larson Lovdal Phone: 740 541 3478 Applicant's <u>email</u> & mailing address <u>Tovdal@theshg.com</u>	Street and Number 301 Broadway City Bethlehem State PA Zip Code 18015	S. APPLICANT'S SIGNATURE
Phone: 40.541.3478 ess Bordalaetheshe com nber 301 Broadway Cin Bethlehem State PA Zip Code 1	301 Broadway Cin Bethlehem State PA Zip Code 1		Storic & Architectural Review Board – Application form, photographs, and dravings must be it Wednesday of the month in order to be placed on the agenda for the next meeting.         uth Bethlehem & Mount Airy Historic Conservation Commission - Application form, photographs of your building and neighboring buildings <u>intust accomp</u> PHOTOGRAPHS - Photographs of your building and neighboring buildings <u>intust accomp</u> Trim and decorative woodwork
Phone: ess and a share phone: nber 301 Broadway City Bethlehem State PA Zip Code 1 VT MUST ATTEND MEETING FOR CASE TO BE HEARD. THE BACK OF THIS APPLICATION TO ENSURE YOUR SUB COMPLETE.	Street and Number 301 Broadway City Bethlehem State PA Zip Code 1 <u>APPLICANT MUST ATTEND MEETING FOR CASE TO BE HEARD.</u> <u>THE CHECKLIST ON THE BACK OF THIS APPLICATION TO ENSURE YOUR SUB</u>	APPLICANT MUST ATTEND MEETING FOR CASE TO BE HEARD. THE CHECKLIST ON THE BACK OF THIS APPLICATION TO ENSURE YOUR SUBN COMPLETE.	as needed
			<b>PHOTOGRAPHS</b> - Photographs of your building and neighboring buildings <u>must accompany</u> your applinducts you will use in this project.         Trim and decorative woodwork       Skylights         x       Siding and Masony       Metal work         Roofing, gutter and downspout       X       Light fixtures         x       Windows, doors, and associated hardware       X       Signs         Storm windows and storm doors
Zip Code 1 D. IR SUBA nitted by next meet	Zip Code 1 <u>IR SUBN</u> nitted by next meet	<u>IR SUBA</u> nitted by aphs, and next meet	TYPE OF WORK PROPOSED - Check all that apply. Please bring any samples or manufactures specificat         products you will use in this project.         Trim and decorative woodwork       Skylights         x       Siding and Masony       Metal work         Roofing, gutter and downspout       x       Light fixtures         x       Windows, doors, and associated hardware
Zip Code 1 D. IR SUBA next meet next meet	Zip Code 1 <u>D.</u> <u>IR SUBN</u> nitted by nitted by next meet next meet	<i>IR SUBA</i> nitted by next meet your appl	products you will use in this project.       Skylights
Zip Code 1 <u>D.</u> <u>IR SUBA</u> <i>nitted by</i> <i>nitted by</i> <i>next meet</i> <i>next meet</i> specifica	Zip Code 1 <u>IR SUBN</u> nitted by aphs, and next meet specifica	<i>IR SUBA</i> nitted by aphs, and next meet your appl	
<i>D.</i> <i>D.</i> <i>TR SUBN</i> <i>next meet</i> your appl	Zip Code 1 <u>D.</u> <u>IR SUBN</u> mitted by mext meet next meet your appl	<i>TR SUBA</i> mitted by aphs, and next meet your appl	x       Stding and Masonry
Zip Code 1 IR SUBA nitted by next meet specifica	Zip Code 1 IR SUBA nitted by applis, and next meet specifica	<i>IR SUBA</i> nitted by aphs, and next meet your appl	_x       Windows, doors, and associated hardware       _x       Signs         _sourn windows and storm doors
Zip Code 1 <u>D.</u> <u>IR SUBN</u> nitted by next meet next meet specifica	Zip Code 1 <u>IR SUB</u> A nitted by next meet specifica	<i>IR SUBA</i> mitted by next meet your apply	x       Windows, doors, and associated hardware       x       Signs         Storm windows and storm doors       Demolition         Shutters and associated hardware       Other         x       Paint (Submit color chips – HARB only)         DRAWINGS OF PROPOSED WORK – Required drawings <u>must accompany</u> your application. Please subm <i>RIGINAL AND TEN (10) COPIES OF DRAWINGS, PHOTOGRAPHS, APPLICATION FORM,</i> PECIFICATIONS         x       Alteration, renovation, restoration (1/4 or 1/8"=1'0" scale drawings required IF walls or openings altere         New addition (1/4" or 1/8"=1'0" scale drawings: elevations, floor plans, site plan)         Demolition, removal of building features or building (1/4" or 1/8"=1'0" scale drawings: elevation of ren and site plan)         A scale drawing, with an elevation view, is required for all sign submittals         DESCRIBE PROJECT – Describe any work checked in #2 and #3 above. Attach additional sheets as needeed see attached document with description and photos.
Zip Code 1 <u>D.</u> <u>IR SUBN</u> nitted by next meet specifica	Zip Code 1 IR SUBA nitted by next meet your appl	<i>IR SUBA</i> nitted by next meet your appi	Storm windows and storm doors       Demotion
Zip Code 1 <u>D.</u> <u>IR SUBN</u> <i>itted by</i> <i>next meet</i> specifica	Zip Code 1 <u>IR SUB</u> A nitted by next meet specifica	<i>IR SUBA</i> nitted by next meet your appl	_xPaint (Submit color chips - HARB only)
<i>D.</i> <i>IR SUBA</i> <i>next meet and next meet specifica</i>	<i>D.</i> <i>IR SUBA</i> <i>nitted by</i> <i>next meet</i> <i>next meet</i> <i>specifica</i>	<i>IR SUBA</i> nitted by your apply specifica	<ul> <li>DRAWINGS OF PROPOSED WORK – Required drawings <u>must accompany</u> your application. Please subm <i>RIGINAL AND TEN (10) COPIES OF DRAWINGS, PHOTOGRAPHS, APPLICATION FORM,</i></li> <li><u>PECIFICATIONS</u> <ul> <li><u>x</u> Alteration, renovation, restoration (1/4 or 1/8"=1'0" scale drawings required IF walls or openings altere</li> <li>New addition (1/4" or 1/8"=1'0" scale drawings: elevations, floor plans, site plan)</li> <li>Demolition, removal of building features or building (1/4" or 1/8"=1'0" scale drawings: elevations, floor plans, site plan)</li> <li>A scale drawing, with an elevation view, is required for all sign submittals</li> </ul> </li> <li>DESCRIBE PROJECT – Describe any work checked in #2 and #3 above. Attach additional sheets as needec See attached document with description and photos.</li> </ul>
Zip Code 1 IR SUBA next meet specifica	Zip Code 1 IR SUBA next meet specifica	<i>TR SUBA</i> <i>aphs, and</i> <i>next meet</i> <i>specifica</i>	<ul> <li>PECIFICATIONS</li> <li></li></ul>
<i>D.</i> <i>IR SUBN</i> <i>nitted by</i> <i>nitted by</i> <i>next meet</i> <i>next meet</i> <i>specifica</i>	<i>TR SUBA</i> <i>TR SUBA</i> <i>itted by</i> <i>nitted by</i> <i>next meet</i> <i>next meet</i> <i>specifica</i>	<i>TR SUBA</i> <i>nitted by</i> <i>aphs, and</i> <i>next meet</i> <i>next meet</i> <i>specifica</i> lease subr	<ul> <li><u>x</u> Alteration, renovation, restoration (1/4 or 1/8"=1 '0" scale New addition (1/4" or 1/8"=1 '0" scale drawings: elevation New building or structure (1/4" or 1/8"=1 '0" scale drawing Demolition, removal of building features or building (1/4" and site plan)</li> <li>A scale drawing, with an elevation view, is required for all</li> <li>DESCRIBE PROJECT – Describe any work checked in #2 and See attached document with description and photos.</li> </ul>
<i>TR SUBA</i> <i>TR SUBA</i> <i>initted by</i> <i>next meet</i> <i>next meet</i> <i>specifica</i> <i>specifica</i>	<i>Tip Code</i> 1 <i>IR SUBA</i> <i>aphs, and</i> <i>next meet</i> <i>next meet</i> <i>specifica</i> <i>specifica</i> <i>FORM</i> .	<i>TR SUBA</i> <i>aphs, and</i> <i>next meet</i> <i>your appl</i> <i>your appl</i> <i>your appl</i> <i>specifica</i> <i>specifica</i>	<ul> <li>New addition (1/4" or 1/8"=1"0" scale drawings: elevation</li> <li>New building or structure (1/4" or 1/8"=1"0" scale drawing</li> <li>Demolition, removal of building features or building (1/4" and site plan)</li> <li>A scale drawing, with an elevation view, is required for all</li> <li>DESCRIBE PROJECT – Describe any work checked in #2 and See attached document with description and photos.</li> </ul>
<i>IR SUBA</i> <i>IR SUBA</i> <i>nitted by</i> <i>next meet</i> <i>next meet</i> <i>next meet</i> <i>specifica</i> <i>specifica</i> <i>specifica</i>	<i>Dp.</i> <i>IR SUBA</i> <i>nitted by</i> <i>nitted by</i> <i>next meet</i> <i>next meet</i> <i>your app</i> <i>your app</i> <i>your app</i> <i>your app</i> <i>your app</i> <i>your app</i> <i>your app</i>	<i>TR SUBA</i> <i>aphs, and</i> <i>next meet</i> <i>your appl</i> <i>your appl</i> <i>your appl</i> <i>your appl</i> <i>your appl</i>	Demolition, removal of building features or building (1/4" and site plan) A scale drawing, with an elevation view, is required for all DESCRIBE PROJECT – Describe any work checked in #2 and See attached document with description and photos.
<i>D.</i> <i>D.</i> <i>IR SUBA</i> <i>aphs, and</i> <i>next meet</i> <i>next meet</i> <i>specifica</i> <i>specifica</i> <i>specifica</i>	<i>D.</i> <i>IR SUBA</i> <i>aphs, and</i> <i>next meet</i> <i>next meet</i> <i>specifica</i> <i>specifica</i> <i>ease subr</i> <i>FORM</i> ,	<i>TR SUBA</i> <i>inext meet meet mext meet mext meet meet m</i>	A scale drawing, with an elevation view, is required for all sign submit DESCRIBE PROJECT – Describe any work checked in #2 and #3 above. See attached document with description and photos.
<i>IR SUBA</i> <i>IR SUBA</i> <i>inted by</i> <i>next meet</i> <i>next meet</i> <i>your appl</i> <i>your appl</i> <i>your appl</i> <i>specifica</i> <i>specifica</i> <i>foRM.</i>	<i>TR SUBA</i> <i>TR SUBA</i> <i>inext meet</i> <i>next meet</i> <i>your appl</i> <i>your appl</i> <i>your appl</i> <i>specifica</i> <i>specifica</i> <i>FORM.</i>	<i>IR SUBA</i> <i>nitted by</i> <i>aphs, and</i> <i>next meet</i> <i>next meet</i> <i>specifica</i> <i>specifica</i> <i>specifica</i> <i>FORM</i> .	DESCRIBE PROJECT – Describe any work checked in #2 and #3 above. See attached document with description and photos.
<i>Ip Code</i> 1 <i>IR SUBN</i> <i>nitted by</i> <i>next meet</i> <i>next meet</i> <i>specifica</i> <i>specifica</i> <i>ings alter</i>	<i>D.</i> <i>IR SUBA</i> <i>nitted by</i> <i>next meet</i> <i>next meet</i> <i>your appl</i> <i>your appl</i> <i>your appl</i> <i>specifica</i> <i>specifica</i> <i>roRM.</i>	<i>TR SUBA</i> <i>aphs, and next meet next meet mext meet specifica</i> specifica	DESCRIBE PROJECT – Describe any work checked in #2 and #3 above. See attached document with description and photos.
<i>TR SUBA</i> <i>TR SUBA</i> <i>TR SUBA</i> <i>inext meet</i> <i>next meet</i> <i>specifica</i> <i>specifica</i> <i>FORM</i> ,	<i>TR SUBA</i> <i>TR SUBA</i> <i>TR SUBA</i> <i>aphs, and</i> <i>next meet</i> <i>next meet</i> <i>next meet</i> <i>specifica</i> <i>specifica</i> <i>specifica</i> <i>specifica</i>	<i>TR SUBA</i> <i>initial by</i> <i>aphs, and</i> <i>next meet</i> <i>next meet</i> <i>specifica</i> <i>specifica</i> <i>specifica</i> <i>specifica</i>	
<i>IR SUBA</i> <i>IR SUBA</i> <i>inext meet</i> <i>ings alter</i> <i>FORM</i> , <i>as neede</i>	<i>D.</i> <i>D.</i> <i>IR SUBA</i> <i>applis, and</i> <i>next meet</i> <i>next meet</i> <i>specifica</i> <i>specifica</i> <i>FORM,</i> <i>FORM,</i> <i>as neede</i>	<i>TR SUBA</i> <i>inted by</i> <i>as neede</i>	1
<i>IR SUBA</i> <i>IR SUBA</i> <i>inted by</i> <i>inted by</i> <i>specifica</i> <i>specifica</i> <i>specifica</i> <i>specifica</i> <i>as neede</i>	<i>TR SUBA</i> <i>TR SUBA</i> <i>TR SUBA</i> <i>inext meet</i> <i>specifica</i> <i>specifica</i> <i>roRM</i> , <i>FORM</i> , <i>as neede</i>	<i>TR SUBA</i> <i>inted by</i> <i>as neede</i>	APPLICANT'S SIGNATURE PHASE / TOAR

# General Description

324 West Fourth Street & 327 Broadway is a single build that emerged through several stages of combination and alteration over the last century. Originally built as the South Bethlehem Supply Company at 327 Broadway and Degnan's Department Store 322-324 West Fourth Street. The building has progressed through many uses, most recently a garage. The intention of this project is to significantly reinvest in the building, upgrading it once again to occupied space. The anchor tenant will be an emerging microbrewery on the first level opening onto Broadway. All facades will be improved based on historic photographic images and existing elements of the building, often found concealed under layers of newer construction. 327 Broadway is a three story structure with a distinctive shape. Due to the site's sloped topography, the Fourth Street elevation is two stories tall and the Broadway elevation is three stories tall (Fourth Street's first level is Broadway's second level). Fourth Street's elevation is approximately 80 feet long and Broadway's elevation is approximately 45 feet long. Two sections of the east elevation share the walls of its neighbors and a small section faces a rear courtyard One section of the west elevation shares the wall of its neighbor and the remaining west elevation faces a parking lot.

The building first appeared on Sanborn insurance maps between 1885 and 1887 and it was labeled as "South Bethlehem Supply Company." Early photos of the South Bethlehem Supply Company indicated that the building was brick and had second and third story windows. In the 1912 Sanborn insurance map the building was labeled as "J.M. Degnan Company." A 1915 advertisement indicated that the company was a department store. After 1915, the building's use is unknown. The facades facing Fourth Street, Broadway, and the parking lot were then altered to accommodate the building's current use as a parking structure. All windows on the Fourth Street and Broadway facades were replaced with larger windows and stucco or EIFS was placed over the existing brick. A stucco or EIFS wall was then placed over the still in place second floor windows on the Fourth Street facade.

of the travel lane and along the Fourth Street wall. There is a single lane ramp with a steep grade leading circulation with the entrance at the Fourth Street elevation. Parking spaces are located on the east side staircase is located in a corner against the Broadway elevation. The second level has a two way located along the wall facing Fourth Street, and on both sides of the single travel lane. An enclosed way circulation, with the entrance at the west elevation and the exit at Broadway. Parking spaces are brick. Three years ago, solar panels were placed on the roof and are still in use today. The garage's openings and a vehicle entrance on the first level and two window openings on the second level. The and glass panes still in-tact, and the other four are openings. The facade is covered with painted stucco roof. Broadway's elevation contains eight windows and a vehicle exit. Four of the windows have frames second level is a featureless stucco or EIFS wall stretching the length of the facade and upward to the up to the third level along the west elevation. A staircase is located in a comer near the Fourth Street interior contains three levels of parking covering the entire area of the building. The first level has a one east wall of the garage open to the rear courtyard contains no windows and is made of the original 1886 or EIFS and includes columns and detailing, which are remnants of the facade that existed before the Fourth Street's facade has a large opening and a vehicle entrance stretching across the first level. Its building's transformation. The painted stucco or EIFS west facades of the garage have five window

elevation and the enclosed staircase against the Broadway elevation continues from the first level. The third level has parking on the west side of the travel lane and parking along the Fourth Street elevation. The enclosed staircase continues from the second and first levels. Five windows exist along the Fourth Street elevation and all of them are covered on the outside by the stucco wall. Much of the interior is in a deteriorating state. Water damage can be seen in the third level, all the window panes have been broken, and the structure itself is crumbling. The basement of the building showed more evidence of the deteriorating state of the building. All the original columns were either wood or steel that has been mostly rusted away. Tens of newer columns have been placed to support the weight of the building, and many of the walls were crumbling.

consolidated with the South Bethlehem Supply Company under the firm name of J.M. Degnan Company. Company was Robert Linderman, who was also the Director of the Bethlehem Iron Company. This store Broadway had a first floor entrance and Fourth Street had a second floor entrance. One of the store's Building (1910). The architect and the builders of the building are unknown. The building was built hardware, furniture, utensils, clothing, dry goods, and household and personal supplies. In 1915, the department store specialized in the buying, selling, trading, and dealing in groceries, provisions, High School. After his father's death, he took over the company and in November 1911 the firm one of the managers and a large stockholder of the company. Additionally, Fenner was the President of one of the finest and best equipped packing and refrigeration plants in the country. Francis Fenner was chief departments was the buying, preparing, and selling of meats. In 1886, the company constructed sometime in 1886. The South Bethlehem Supply Company, which was the building's first tenant, was Church (1910), Windish Hall (c. 1915), and the Banana Factory (c. 1900), and the E.P. Wilbur Trust Firehouse (Touchstone Theater, 1875), Holy Infancy Catholic Church (1892), St. John Windish Lutheran buildings, the South Bethlehem Post Office (1916), Bethlehem Public Library (1929), Protection from about 1900 to 1935. Notable non-residential buildings include 2 several Bethlehem Steel-related commercial, municipal, industrial and residential buildings in Bethlehem. Most of the buildings date contributing objects. It encompasses a concentration of late-19th through early 20th century Bethlehem, Northampton County, Pennsylvania. The district includes 288 contributing buildings and 2 Statement of Significance: The South Bethlehem historic District is a National Historic District located in department store was a sponsor for the South Bethlehem semi-centennial celebration and its events. the community. James Degnan worked with his father's business after graduating from South Bethlehem Hill were rapidly expanding. The J. M. Degnan Company Department Store also played a major role in the Sehiller Mining Company in Aspen, Colorado. The chairman of the South Bethlehem Supply once one of the largest general stores in Pennsylvania. It had a floor space of 20,370 square feet. It was a department store that owned and operated locations on Third and Fourth Streets. The was a major contributor to South Bethlehem's growth at a time when South Bethlehem and Fountain

The building has been assessed by the Pennsylvania Historical & Museum commission for historic tax credit as a contributing building. It was denied based on the extreme alterations of the building over time. While the building is located in the South Bethlehem Historic District, it is deemed non-contributing. The goal of the work is to make the building contribute significantly to the improvement of the streetscape, pedestrian and civic activity of the SBHD. The objective of Phase I investment is to

create a weather-tight enclose around the entire building structure. This entails providing new windows storefront and doors in all exterior openings.

The second story (Fourth Street level) will remain a parking garage for the immediate future. All openings will be infilled with insulated glass storefront and the space will be conditioned in order to regulate overall building climate. A garage door in the place of the current entrance will allow access for registered vehicles. The necessary exhaust and intake required of a private parking garage will be handled in a way that is not visually obtrusive to the Fourth Street façade, and infilled storefront will bring back historic fenestration details of the original design.

parking in select areas and al fresco dining in others. The cartway width at Broadway will not be entrance. This is not unlike the arrangement on Main Street, where sidewalk width varies to allow exit at this location. The extension will add room for tables as well as an accessible ramp to the front of the building. This will not eliminate any current parking spaces since there is currently a vehicle further enhance the patron experience and provide al fresco seating, a widened sidewalk is proposed in walls can be opened to provide an indoor/outdoor experience for patrons on days of nice weather. To with the third storefront providing entry to the shared vestibule mentioned previously. The folding glass geometry and rhythm of the building. Large folding glass walls will occupy two of the three openings third floor tenants. The Broadway façade will be altered in a way that better reflects the original also serve as access to a vertical circulation stair and elevator providing egress for future second and shared vestibule patrons will enter a second set of doors into the brewery. The shared vestibule will Primary access to the brewery will be through a shared entrance on Broadway. Upon entering the Additionally, Phase I will include the fit-out of the first floor space for Seven Sirens Brewing Company. and appreciated by patrons as well as the general public and help beautify the streetscape. provide seating, and separate the brewery patio and ramp from the public sidewalk. They can be used reduced as a result. Concrete planters will be strategically used to protect pedestrians from the street,





02

322 - 324 W 4<sup>th</sup> Street North façade, looking south Parking Garage (Compiled Image) 4/25/2018







327 Broadway Southwest + southeast façade, looking east Parking Garage, 325 Broadway, Wilbur Trus 12/11/2017



07

327 Broadway + 325 Broadway to east Southeast facade, looking northwest Parking Garage, Metro PCS Retail Store 12/11/2017

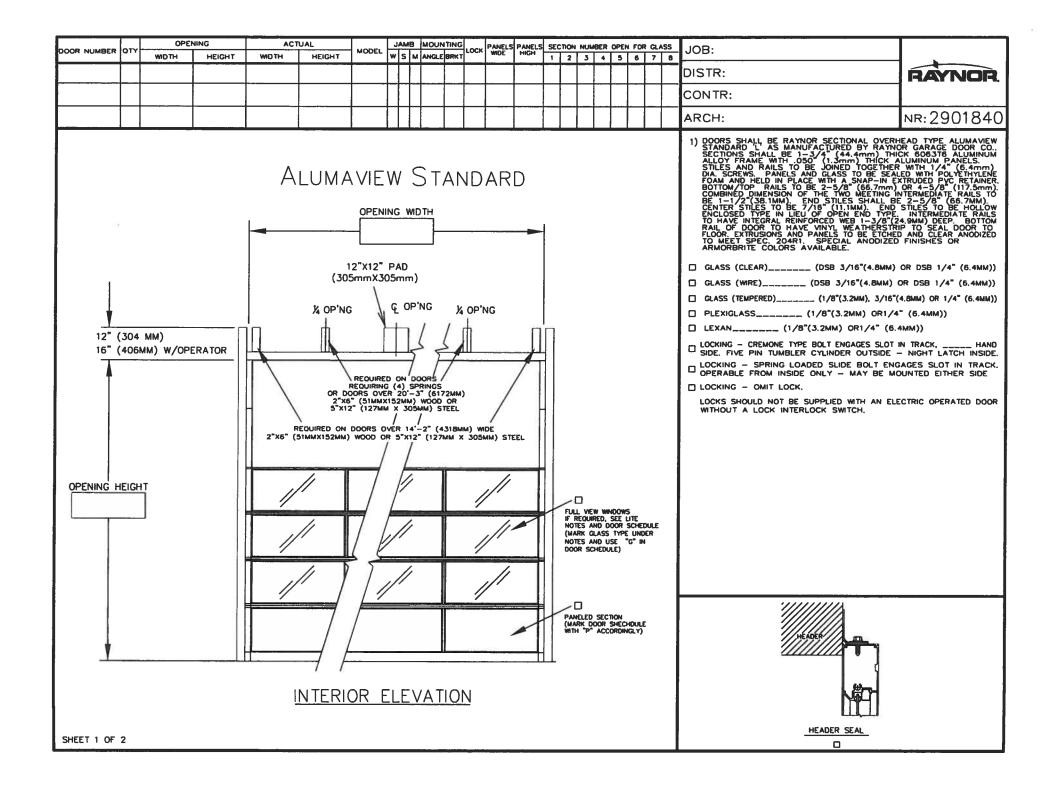

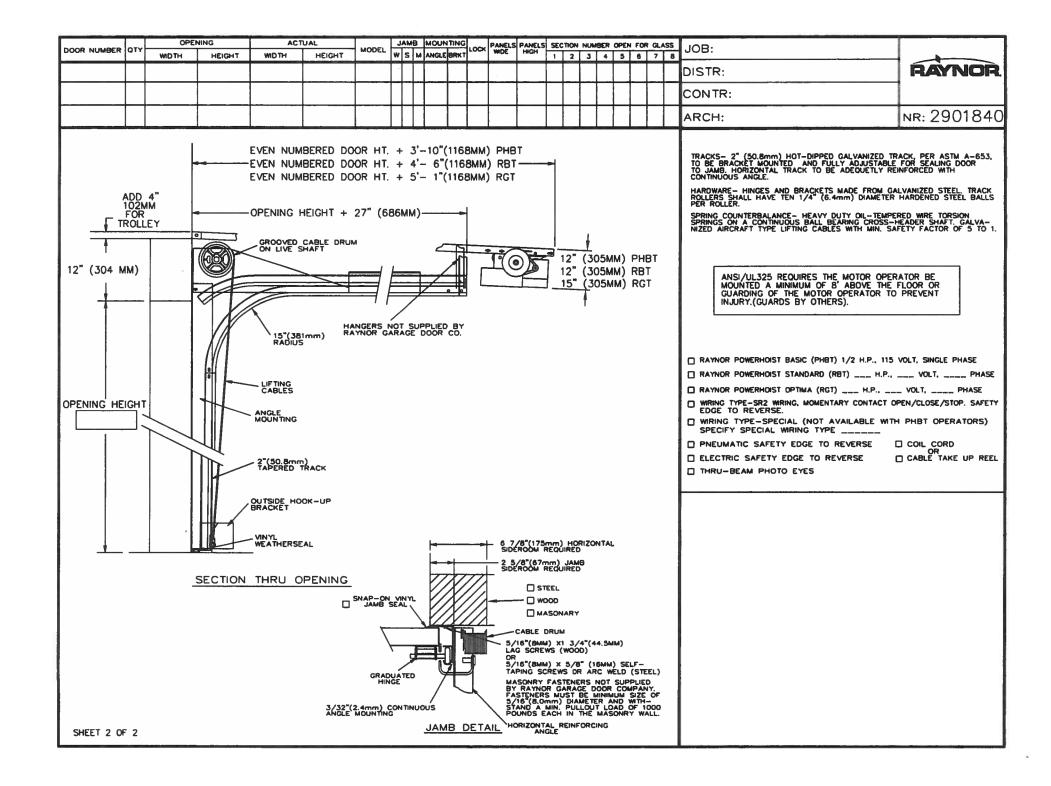




### RENDERING AERIAL

ISSUED FOR APPROVAL 2018\_10\_08

**DRAWN BY** E. Nolter

**PROJECT** Seven Sirens Brewery 327 Broadway Bethlehem, PA 18015

**CLIENT** The Stone House Group 301 Broadway Bethlehem, PA 18015

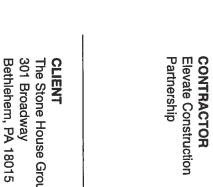






EAST SPRUCE design / build 1408 Chelsea Ave Bethlehem, PA 18018 610.392.5206

**ENGINEER** Pinnacle Engineering

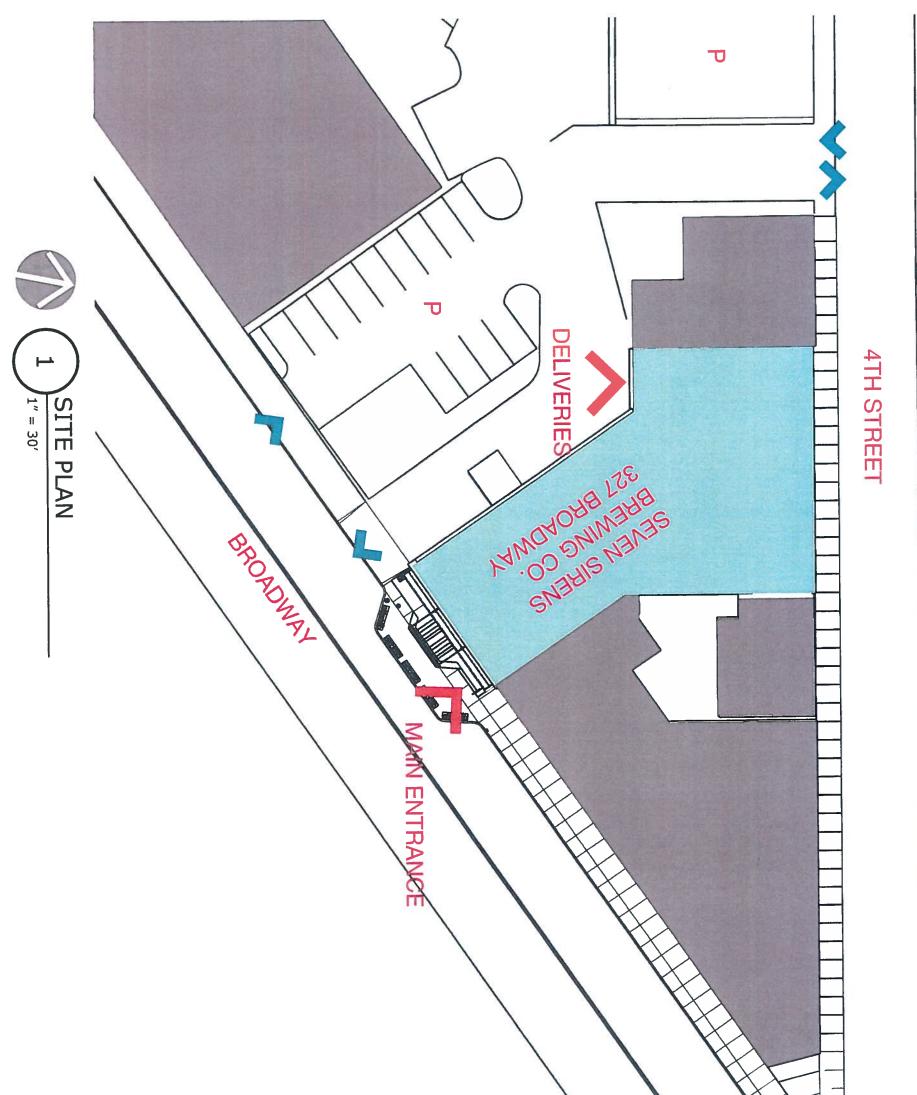

### SITE PLAN

**APPROVAL** 2018\_10\_08 **ISSUED FOR** 

**DRAWN BY** E. Nolter

Bethlehem, PA 18015 PROJECT Seven Sirens 327 Broadway Brewery

The Stone House Group 301 Broadway Bethlehem, PA 18015 CLIENT


**CONTRACTOR** Elevate Construction Partnership

ENGINEER Pinnacle

Engineering

EAST SPRUCE design / build 1408 Chelsea Ave Bethlehem, PA 18018 610.392.5206

ATTACK OF

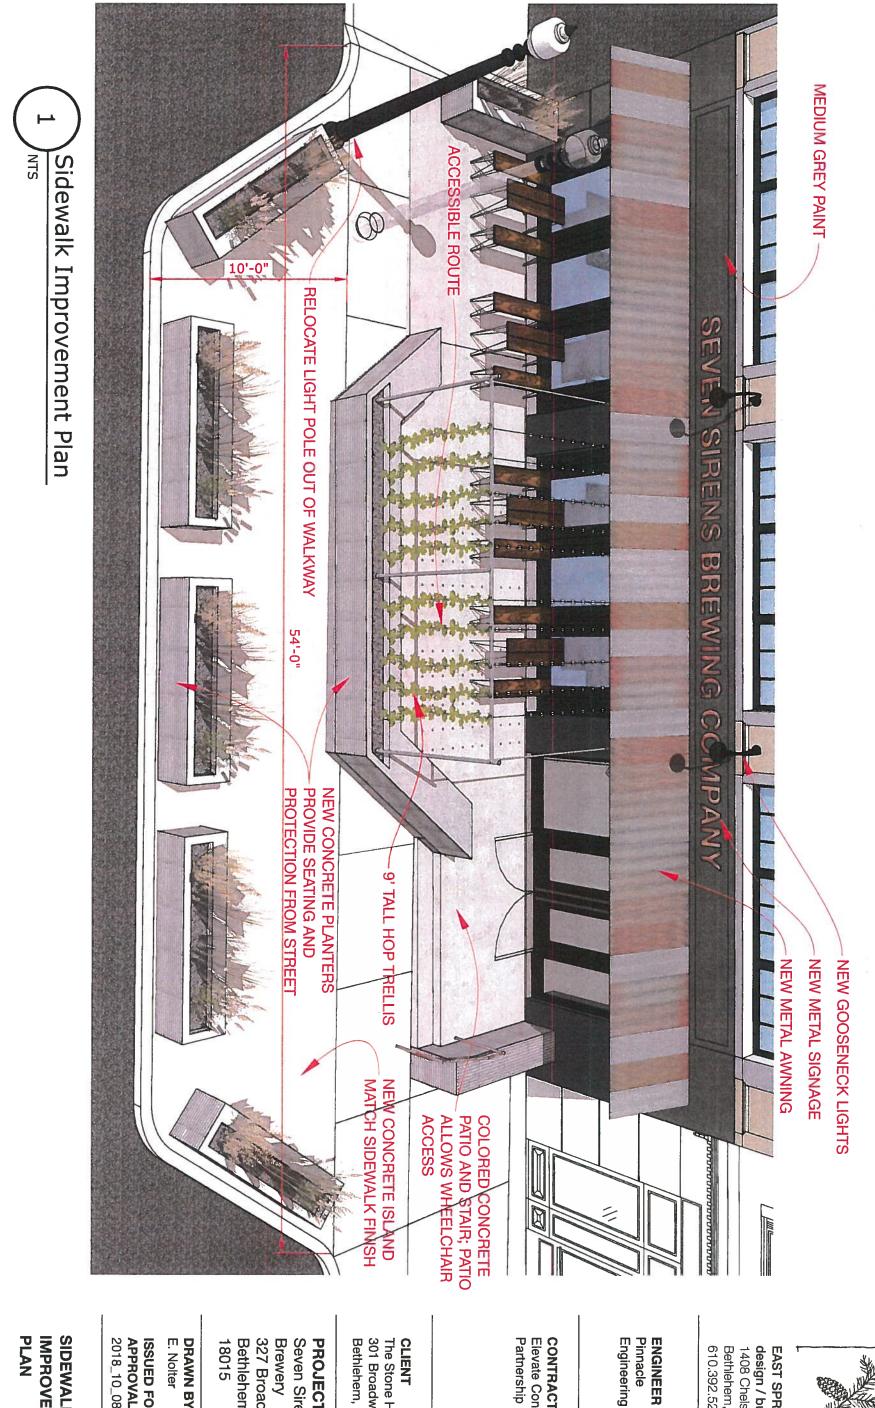



#### PLAN SIDEWALK IMPROVEMENT

**APPROVAL** 2018\_10\_08 **ISSUED FOR** 

**DRAWN BY** E. Nolter

18015 327 Broadway PROJECT Bethlehem, PA Brewery Seven Sirens

Bethlehem, PA 18015 The Stone House Group

301 Broadway

CLIENT


CONTRACTOR Elevate Construction


Bethlehem, PA 18018 610.392.5206

**design / build** 1408 Chelsea Ave EAST SPRUCE


NH AN

Partnership

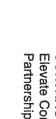

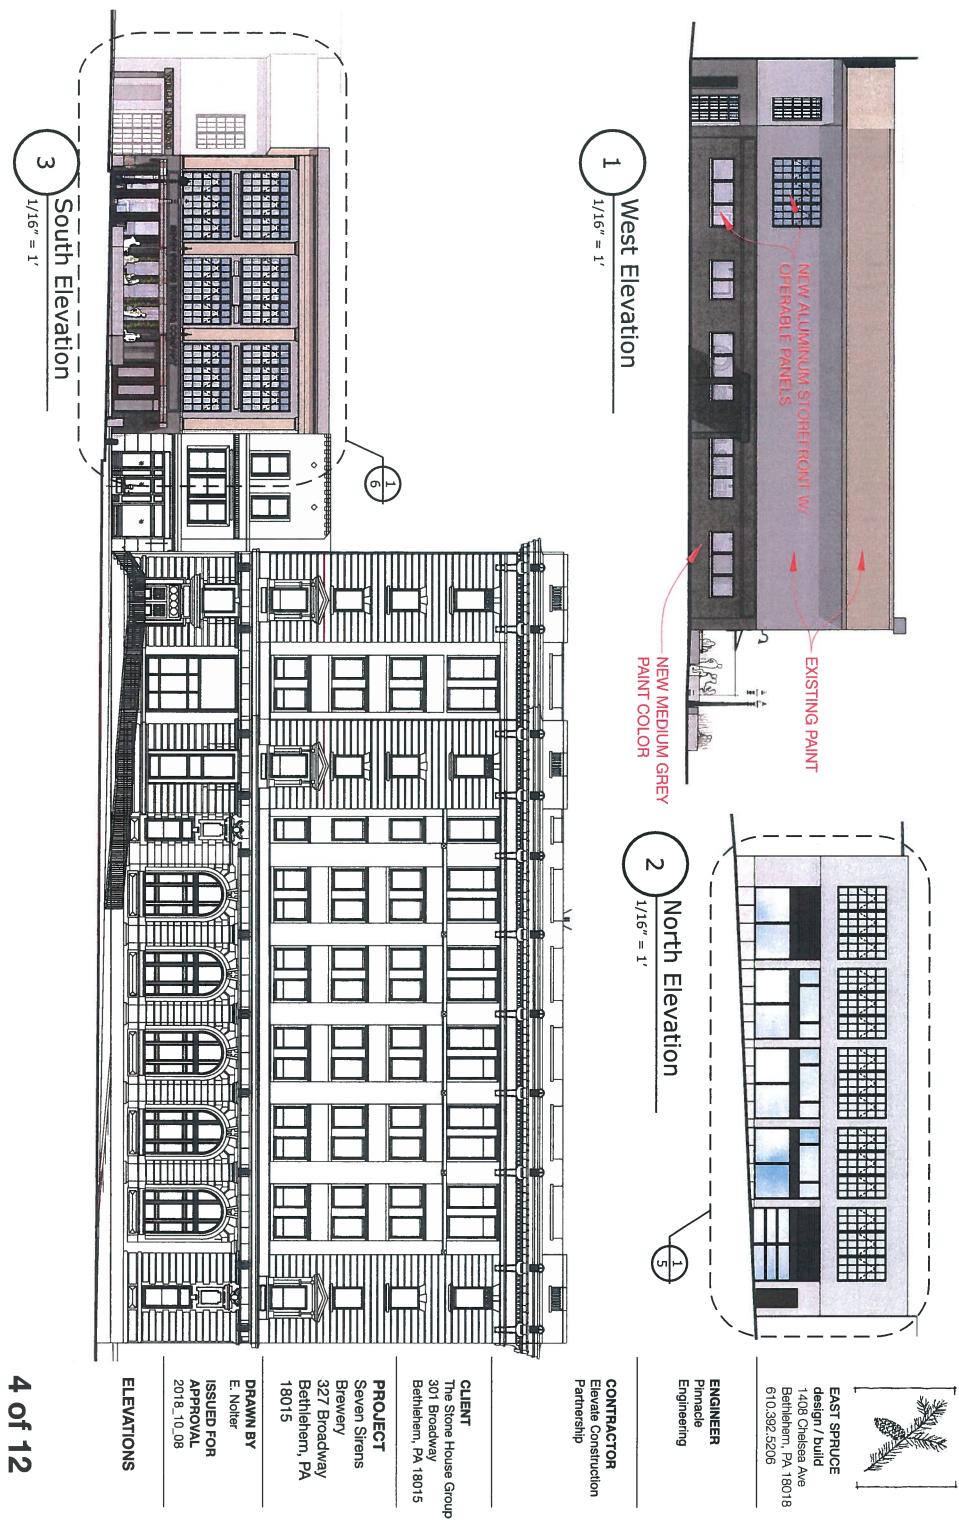

H 1/8'' = 1'North Elevation

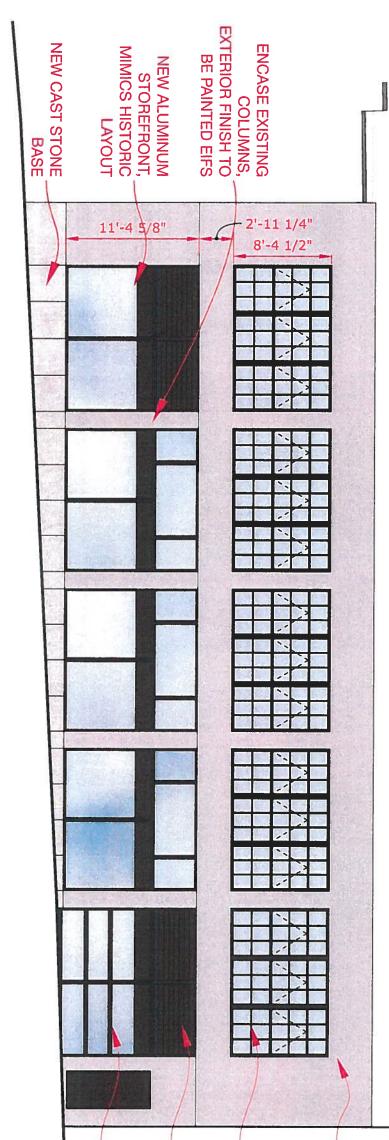



### **ELEVATIONS**

**APPROVAL** 2018\_10\_08 **ISSUED FOR** 

**DRAWN BY** E. Nolter

18015 327 Broadway PROJECT Bethlehem, PA Brewery Seven Sirens

301 Broadway Bethlehem, PA 18015

The Stone House Group CLIENT **CONTRACTOR** Elevate Construction Partnership

DOOR 8' HIGH GLASS GARAGE

INTEGRATED INTAKE AND ARCHITECTURALLY **EXHAUST** 

STOREFRONT W/ OPERABLE PANELS **NEW ALUMINUM** 

- NEW PAINT TO FACADE MATCH SOUTH



610.392.5206 Bethlehem, PA 18018 EAST SPRUCE **design / build** 1408 Chelsea Ave

Pinnacle ENGINEER

Engineering

⊢ '3/16" = 1' **Broadway Elevation Detail** 




# 6 of 12

#### **ELEVATION** ENLARGED

Seven Sirens Bethlehem, PA 327 Broadway

Bethlehern, PA 18015 The Stone House Group 301 Broadway

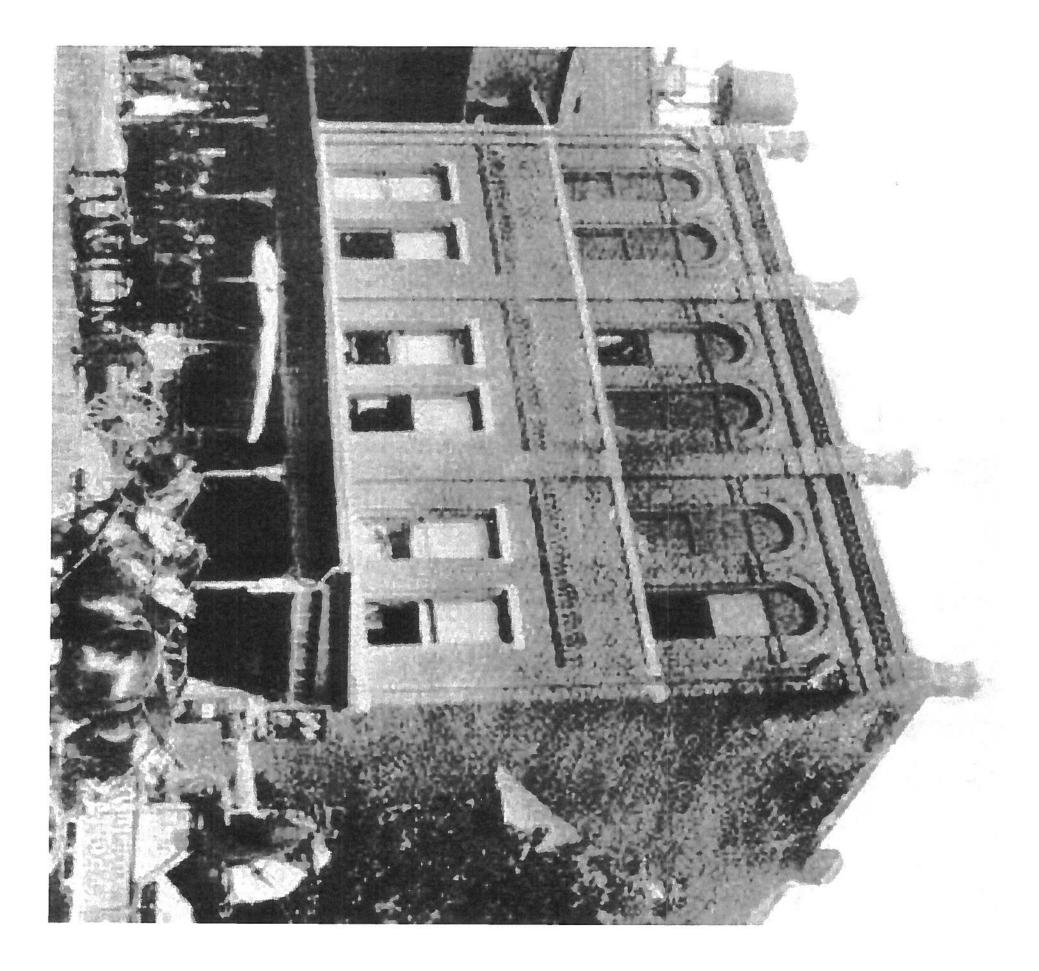

seen here. columns lining the street, abstract interpretation of the concrete planters bring back a sense of grandeur. The sheltering patrons and shading the large expanses of glass on the south facade. back to this image, part of this submission relate nop trellis and awning are an he gestures proposed as a The sidewalk extension and

stories. separating it from upper defined the first level, visually entry and pr the portico distinguished and the street level. A decorative had a significant presence at Historically, or travelers ron portico ovided respite sheltered the 327 Broadway

Architecturally,

### 7 of 12

### PRECEDENT **HISTORIC PHOTO**

2018\_10\_08 APPROVAL **ISSUED FOR** 

**DRAWN BY** E. Nolter

18015 327 Broadway Brewery Bethlehem, PA Seven Sirens PROJECT Bethlehem, PA 18015

The Stone House Group 301 Broadway CLIENT

業


Bethlehem, PA 18018 610.392.5206 EAST SPRUCE design / build 1408 Chelsea Ave

ENGINEER

Pinnacle Engineering

CONTRACTOR

Elevate Construction Partnership

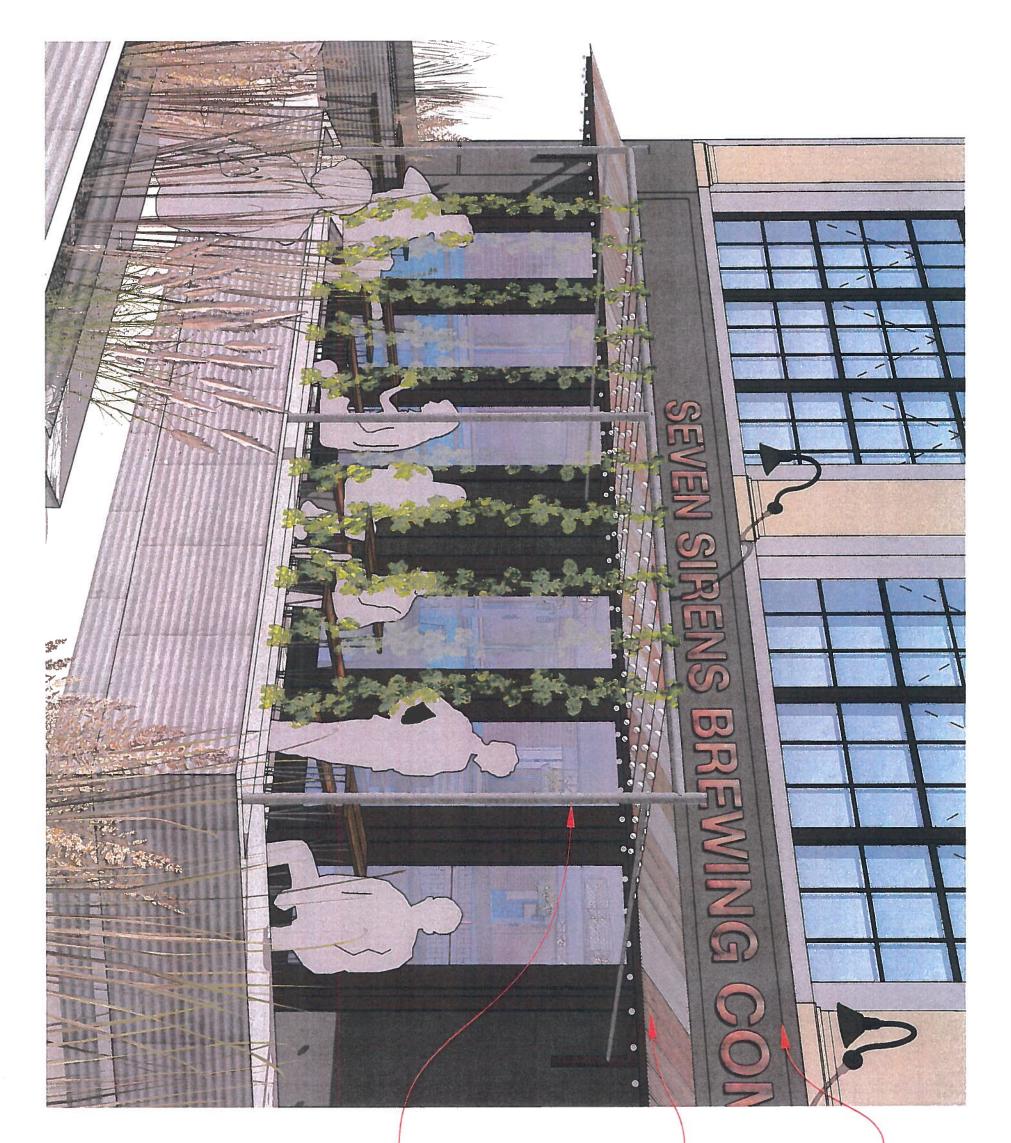

### **3D VIEW**

**APPROVAL** 2018\_10\_08 **ISSUED FOR** 

**DRAWN BY** E. Nolter

18015 Bethlehem, PA 327 Broadway Seven Sirens Brewery

PROJECT

301 Broadway Bethlehem, PA 18015

The Stone House Group

CLIENT

AND HELPS DEFINE THE SPACE AS AN TRELLIS STRUCTURE NOT IN BLOOM, **BIERGARTEN. WHEN** OUTDOOR ROOM OR INTERPRETATION OF VISUALLY OBTRUSIVE. ALONE IS NOT HISTORICAL PORTICO ABSTRACT HOP TRELLIS IS AN

FROM THE STORIES AND SET IT APART DEFINE FIRST FLOOR **NEW PAINT HELPS** 

610.392.5206 design / build Bethlehem, PA 18018 1408 Chelsea Ave EAST SPRUCE

ENGINEER Pinnacle


Engineering

Partnership Elevate Construction CONTRACTOR

SOUTH BETHLEHEM.

EXISTING PALETTE. GRAY COLOR WILL COMPLIMENT ABOVE. MEDIUM

AN EXTENSION OF THE CORRUGATED METAL IS PROTECTION AT ENTRY. SHADE AT SOUTH FACING INDUSTRIAL NATURE OF AND APPROPRIATE TO SEVEN SIRENS BRAND GLASS AND RAIN **AWNING PROVIDES** 

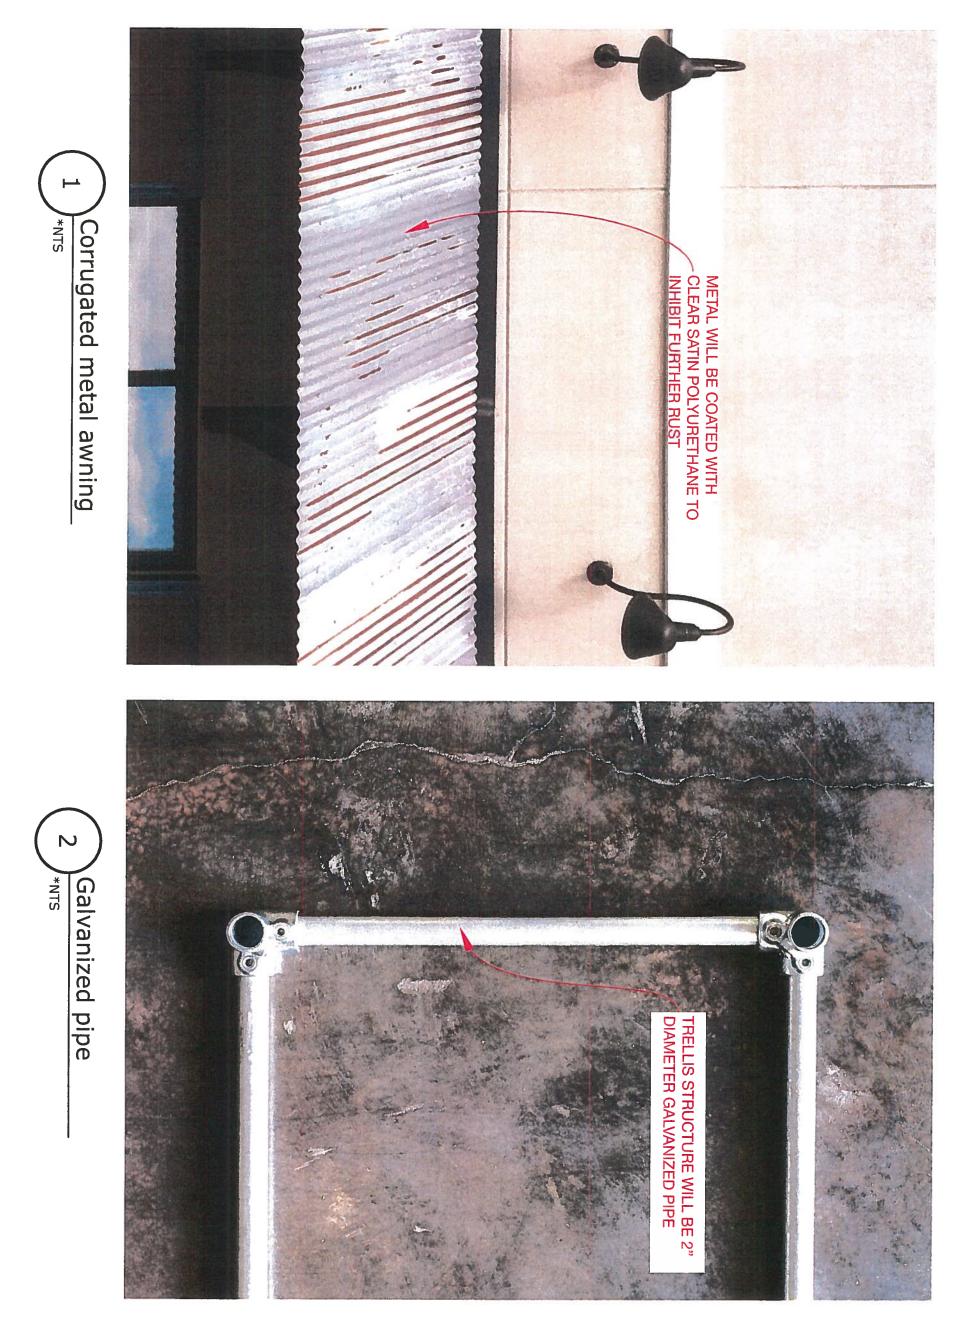

### ELEMENTS ARCHITECTURAL

ISSUED FOR APPROVAL 2018\_10\_08

**DRAWN BY** E. Nolter

327 Broadway Bethlehem, PA PROJECT Seven Sirens 18015 Brewery

The Stone House Group 301 Broadway Bethlehem, PA 18015

CLIENT


**ENGINEER** Pinnacle Engineering







EAST SPRUCE design / build 1408 Chelsea Ave Bethlehem, PA 18018 610.392.5206

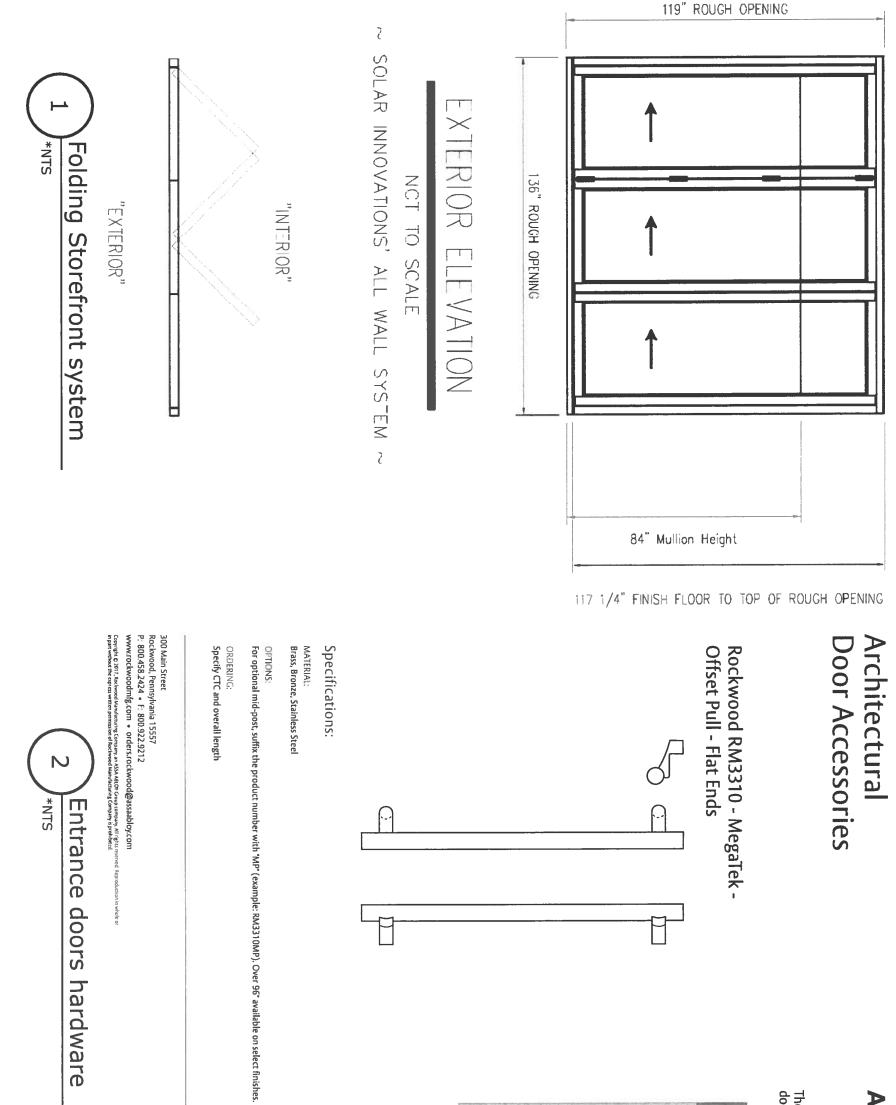

### **ELEMENTS** ARCHITECTURAL

**APPROVAL** 2018\_10\_08 **ISSUED FOR** 

DRAWN BY E. Nolter

18015 Brewery Bethlehem, PA 327 Broadway Seven Sirens PROJECT

Bethlehem, PA 18015 301 Broadway The Stone House Group

CLIENT

CS-RM3310 1/17

Available Finishes:

Partnership

CONTRACTOR Elevate Construction

Pinnacle

ENGINEER

Engineering

The global leader in door opening solutions




ASSA ABLOY



design / build 610.392.5206 Bethlehem, PA 18018 1408 Chelsea Ave



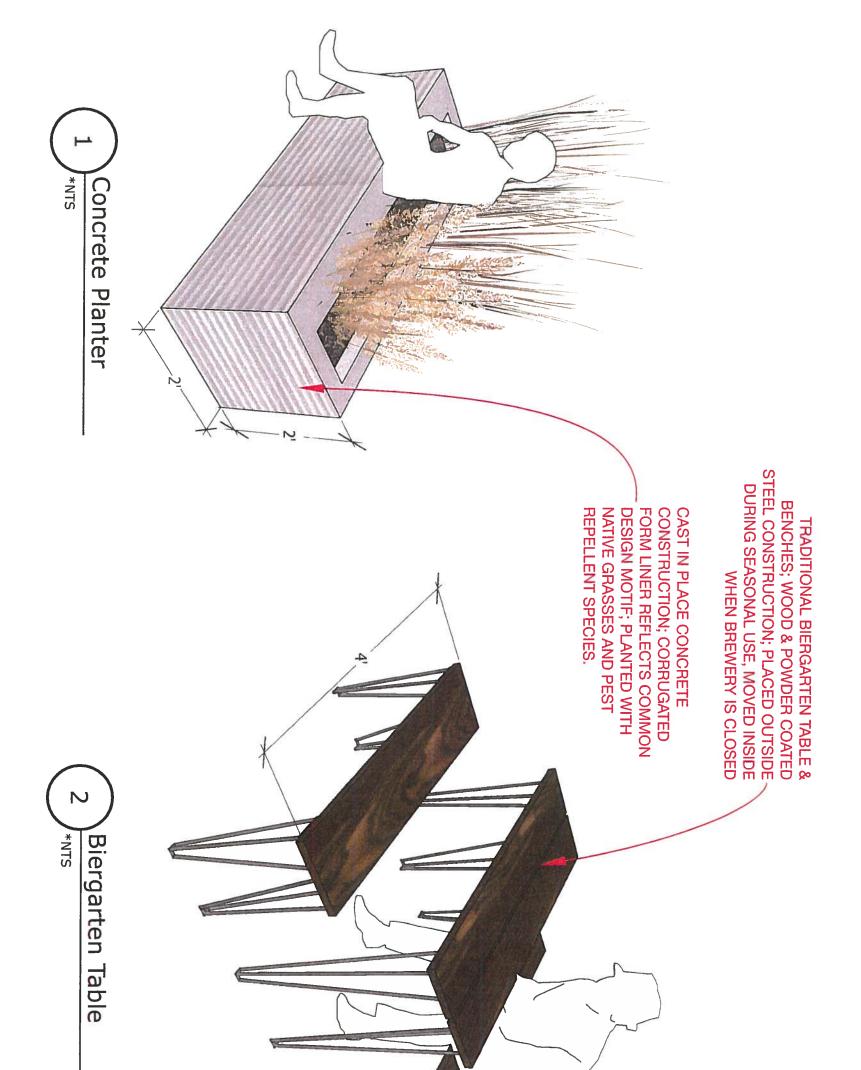

#### SITE AND PLANTERS FURNISHINGS

**APPROVAL** 2018\_10\_08 **ISSUED FOR** 

**DRAWN BY** E. Nolter

18015 Bethlehem, PA 327 Broadway Brewery PROJECT Seven Sirens

Bethlehem, PA 18015 301 Broadway The Stone House Group CLIENT

Partnership

Elevate Construction

ENGINEER Pinnacle

610.392.5206


1408 Chelsea Ave Bethlehem, PA 18018

design / build EAST SPRUCE

Engineering

CONTRACTOR



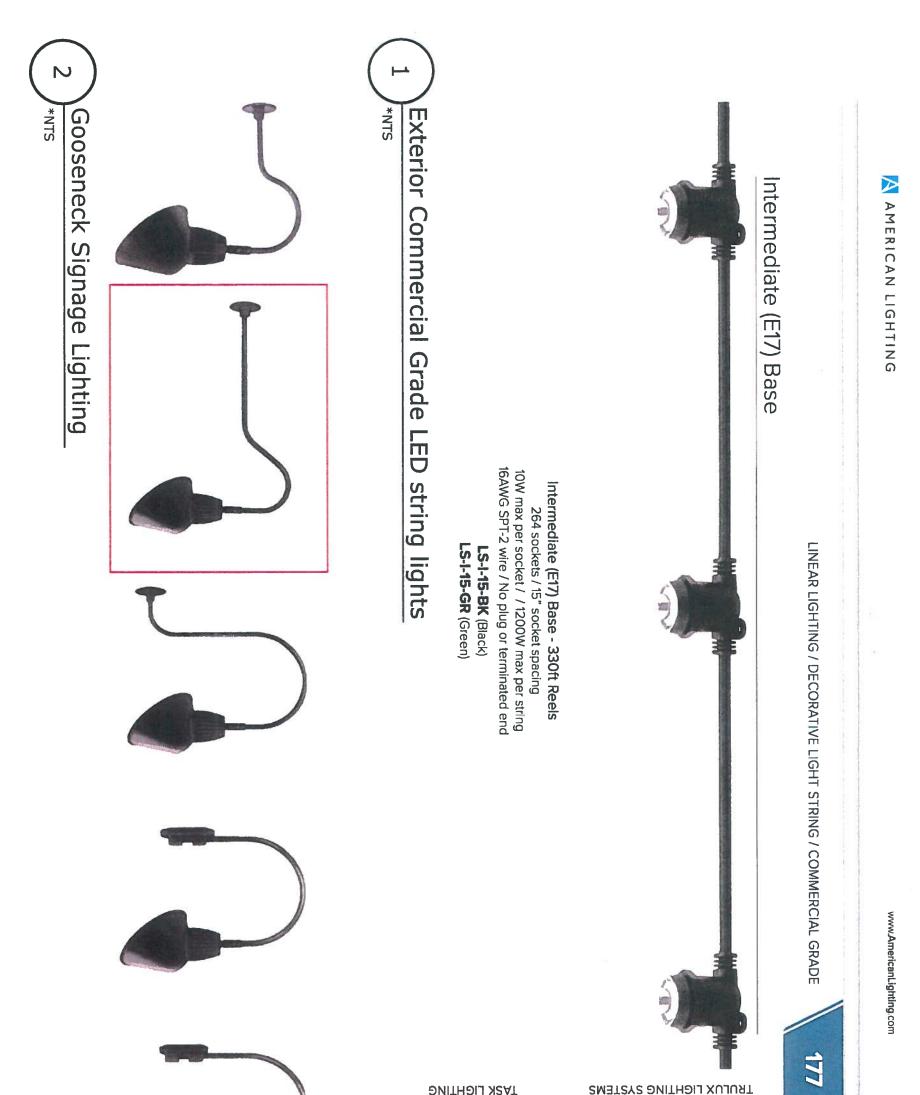



#### EXTERIOR LIGHTING

**APPROVAL** 2018\_10\_08 **ISSUED FOR** 

E. Nolter DRAWN BY 18015 327 Broadway Brewery Bethlehem, PA Seven Sirens PROJECT 301 Broadway Bethlehem, PA 18015 CLIENT The Stone House Group

Partnership

CONTRACTOR Elevate Construction

Engineering Pinnacle ENGINEER

Bethlehem, PA 18018 610.392.5206

**design / build** 1408 Chelsea Ave EAST SPRUCE







